

V022-15803

ADDENDUM NUMBER 1

FRANKLIN LANDFILL
INFRASTRUCTURE UPGRADE
76th Street and Rawson Avenue
Franklin, WI

Project Number: V022-15803

Notice Number: 7003

Date of Addendum: November 5, 2015

This Addendum to the Contract Documents is issued to modify, explain or correct the original documents, dated October 7, 2015, and is hereby made part of the Contract Documents. Acknowledge receipt of this Addendum in the space provided on the Bid Form, or bid may be rejected.

DRAWINGS

Replace Sheet 1 and Sheet 2 with the revised version, dated Nov. 5 (attached).
A table of header profile control points is also provided (attached).

Sheet 2: Add the following to Notes:

6. The volume of CT-1 is assumed to be 500 gal and will be pumped out by Milwaukee County prior to scheduled removal. Tank can be rinsed clean on site prior to off site disposal.
7. The contractor shall restore the disturbed area from station 0+00 thru 2+00 with WisDOT No. 40 seed mix. All other disturbed areas on the east and west sides shall be restored using WisDOT No. 20 seed mix.

PRE-BID MEETING

The attendance list from the Nov 4 pre-bid meeting is attached.

End of Addendum No. 1

MILWAUKEE COUNTY
Department of Administrative Services
PREBID MEETING


DATE: 11/4/15 PLACE: 633 W. Wisconsin 10th floor

NAME	ORGANIZATION	PHONE	EMAIL
Tom TilkenS	Marek Landscaping	920-606-8232	thomas@mareklandscaping.com
Tyler Flory	August Winter-Sons, Inc	920-739-8881	Tflory@augustwinter.com
John Karsten	LANDFILL DRAINAGE & PIPING SPECIALISTS	608-709-2722	jkarsten@landfilldps.com
Chris Steinke	Terra Eng.	609 219 4623	csteinke@whyterra.com
BRIAN ENGEL	MC - CBOP	414 278 4803	BRIAN.ENGEL@MILWAUKEECOUNTYWI.GOV
BRIAN JACOBS	TERRA ENGINEERING	608.852.1287	BJACOBS@WHYTERRA.COM
Chuck Passchil	Marek Landscaping	414 772 0247	chuck@mareklandscaping.com
Jack Dowden	SCS Engineers	262.707.9744	jdowden@scsengineers.com
mike Mahw	Veig	414-704-0815	mmahw@veigusa.com
Steve Keith	Milw County	414 278 4355	stevan.keith@milwaukeecounty.wi.gov
Jack Dowden	SCS		

Franklin County Landfill
Profile Control Points

<u>Point</u>	<u>Station</u>	<u>Elevation</u>
Start	-0+74.99	778.90
CK-1 (in)	-0.19.11	776.66
CK-1 (out)	-0.19.11	778.88
G-7 Lateral	0+51.91	781.79
G-6 Lateral	1+91.12	787.51
Grade Break	1+98.76	787.82
G-5 Lateral	3+54.13	781.60
CK-2 (in)	3+88.99	780.20
CK-2 (out)	3+88.99	783.56
Grade Break	4+51.73	786.06
G-4 Lateral	5+49.72	782.71
G-3 Lateral	6+72.79	773.82
Grade Break	6+97.99	772.00
G-2 Lateral	8+79.68	761.34
Grade Break	9+18.62	759.05
Grade Break	10+43.67	753.00
G-1 Lateral	10+54.66	752.63
G-8 Lateral	12+14.37	747.43
Blind Flange	12+41.53	746.43
End/CK-3	12+54.37	746.00

Milwaukee County

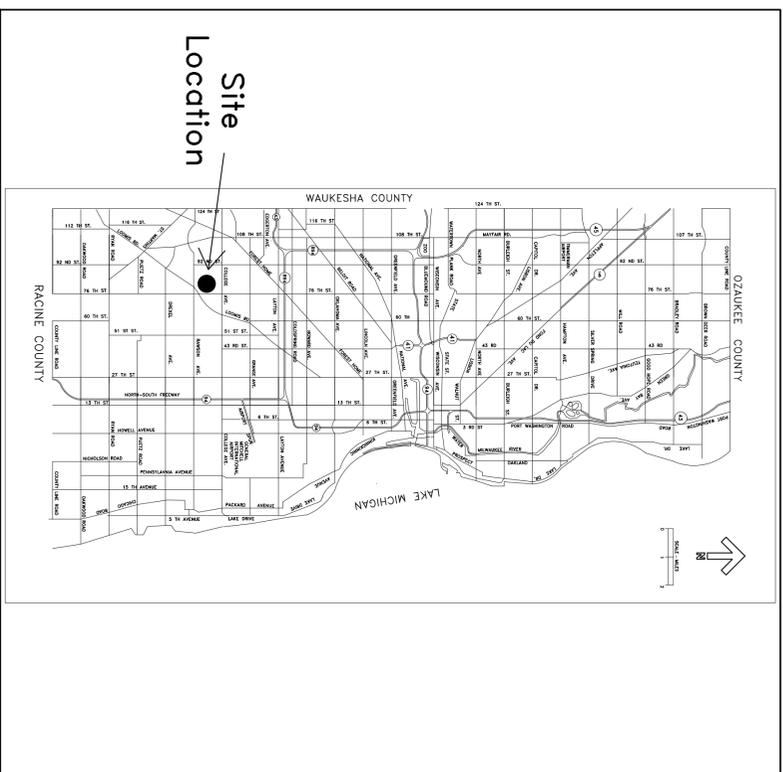

MILWAUKEE COUNTY FRANKLIN LANDFILL

South 76th Street

EASTERN INFRASTRUCTURE UPDATE Landfill Gas Header Replacement

V022-15803

OCTOBER 2015

PROJECT AREA



SUPPLEMENTAL PROJECT AREA

LEGEND:

- X — EXISTING ELECTRIC (BURIED)
- E — EXISTING ELECTRIC (BURIED)
- SURVEY CONTROL POINT
- LIMITS OF WASTE

ABBREVIATIONS:

CO	CLEANOUTS
CK	CONDENSATE KNOCKOUT
CT	CONDENSATE TANK
DIA.	DIAMETER
EL	ELEVATION
HDPE	HIGH DENSITY POLYETHYLENE
HOR	HORIZONTAL
HP	HIGH POINT
I.E.	INVERT ELEVATION
IV	ISOLATION VALVE
MAX	MAXIMUM
MIN	MINIMUM
MH	MANHOLE
PVC	POLYVINYL CHLORIDE
R	RADIUS
SS	STAINLESS STEEL
ST	STREET
TYP	TYPICAL
WEPCO	WI ELECTRICAL POWER CO

GENERAL NOTES

- APPLICATION SPECIFICATIONS - STATE OF WISCONSIN DEPARTMENT OF TRANSPORTATION DIVISION OF HIGHWAYS, STANDARD SPECIFICATIONS FOR HIGHWAY AND STRUCTURE CONSTRUCTION, 2003 EDITION, WITH AMENDMENTS TO DATE, AND STANDARD SPECIFICATIONS FOR SEWER AND WATER CONSTRUCTION IN WISCONSIN.
 - CONTRACTOR SHALL CALL DIGGERS HOTLINE ((414) 259-1181) AND PARKS MAINTENANCE DIVISION AT (414) 258-2322 FOR UTILITIES LOCATION PRIOR TO START OF CONSTRUCTION.
 - ALL INFORMATION SHOWN ON EXISTING CONDITIONS IS BASED ON RECORDS AVAILABLE TO MILWAUKEE COUNTY DEPARTMENT OF ADMINISTRATIVE SERVICES AS OF JUNE 2015. ALTHOUGH THE COUNTY IN NO WAY GUARANTEES THE INFORMATION AS BEING ENTIRELY ACCURATE IN THE EVENT PERSONS PERFORMING WORK FOR MILWAUKEE COUNTY SHOULD ENCOUNTER ERRORS OR OMISSIONS IN THESE DRAWINGS DURING CONSTRUCTION OF THIS PROJECT, IT SHALL BE THEIR RESPONSIBILITY TO INFORM THE COUNTY AS SOON AS POSSIBLE.
 - ALL ELEVATIONS ON THESE DRAWINGS ARE BASED ON NATIONAL GEODETIC VERTICAL DATUM. (CITY OF MILWAUKEE DATUM). SURVEY INFORMATION FOR PROJECT AREA PROVIDED BY MILWAUKEE COUNTY.
 - EXISTING SIGNS AFFECTED BY CONSTRUCTION SHALL BE PROTECTED OR RELOCATED AS DIRECTED BY THE OWNER OR OWNER'S REPRESENTATIVE.
 - CONTRACTOR SHALL SECURE ALL REQUIRED PERMITS, INCLUDING THE PERMIT FOR EROSION CONTROL.
 - POTENTIALLY EXPLOSIVE GAS MAY BE PRESENT IN THE WORK ZONE AND IN THE TRENCHES. CONTRACTORS SHALL TAKE ALL NECESSARY PRECAUTIONS TO PROVIDE A SAFE WORKING ENVIRONMENT.
- CONSTRUCTION SITE EROSION CONTROL**

- SILT FENCE SHALL BE INSTALLED PRIOR TO CONSTRUCTION. OWNER TO STAKE LOCATION PRIOR TO INSTALLATION
- OWNER WILL MARK LIMITS OF DISTURBANCE PRIOR TO CONTRACTOR MOBILIZATION. SILT FENCE TO BE PLACED ON WEST SIDE OF OWNER'S MARKINGS.
- EROSION CONTROL MEASURES SHALL BE INSTALLED PER THE WISCONSIN CONSTRUCTION SITE BEST MANAGEMENT PRACTICES HANDBOOK.
- COMPLY WITH ALL LOCAL AND STATE EROSION CONTROL ORDINANCES.
- SOIL STOCKPILE LOCATION SHALL BE WITHIN AREA PROTECTED BY EROSION AND SEDIMENT CONTROL MEASURES.

DRAWING INDEX:

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MILWAUKEE COUNTY DEPARTMENT OF
ADMINISTRATIVE SERVICES
Architecture, Engineering &
Environmental Services Section

633 W. WISCONSIN AVE. SUITE 1000, MILWAUKEE, WI 53203



RECOMMENDED FOR APPROVAL BY: _____
DATE _____ DIRECTOR - (owner dept.)

PROJECT APPROVAL BY: _____
DATE _____ DIRECTOR-DAS

PROJECT MANAGER REVIEW BY: _____
DATE _____

UNIT MANAGER REVIEW BY: _____
DATE _____


REVISIONS:

1	Sheet 2	11/5/15


BUILDING NO.	
SITE NO.	
PROJECT NO.	V022-15803
SHEET NO.	1
FILE NO.	

I:\PROJECT\2014 Projects\25214039.15 Milwaukee Co - Franklin Landfill Header Design

PROJECT AREA

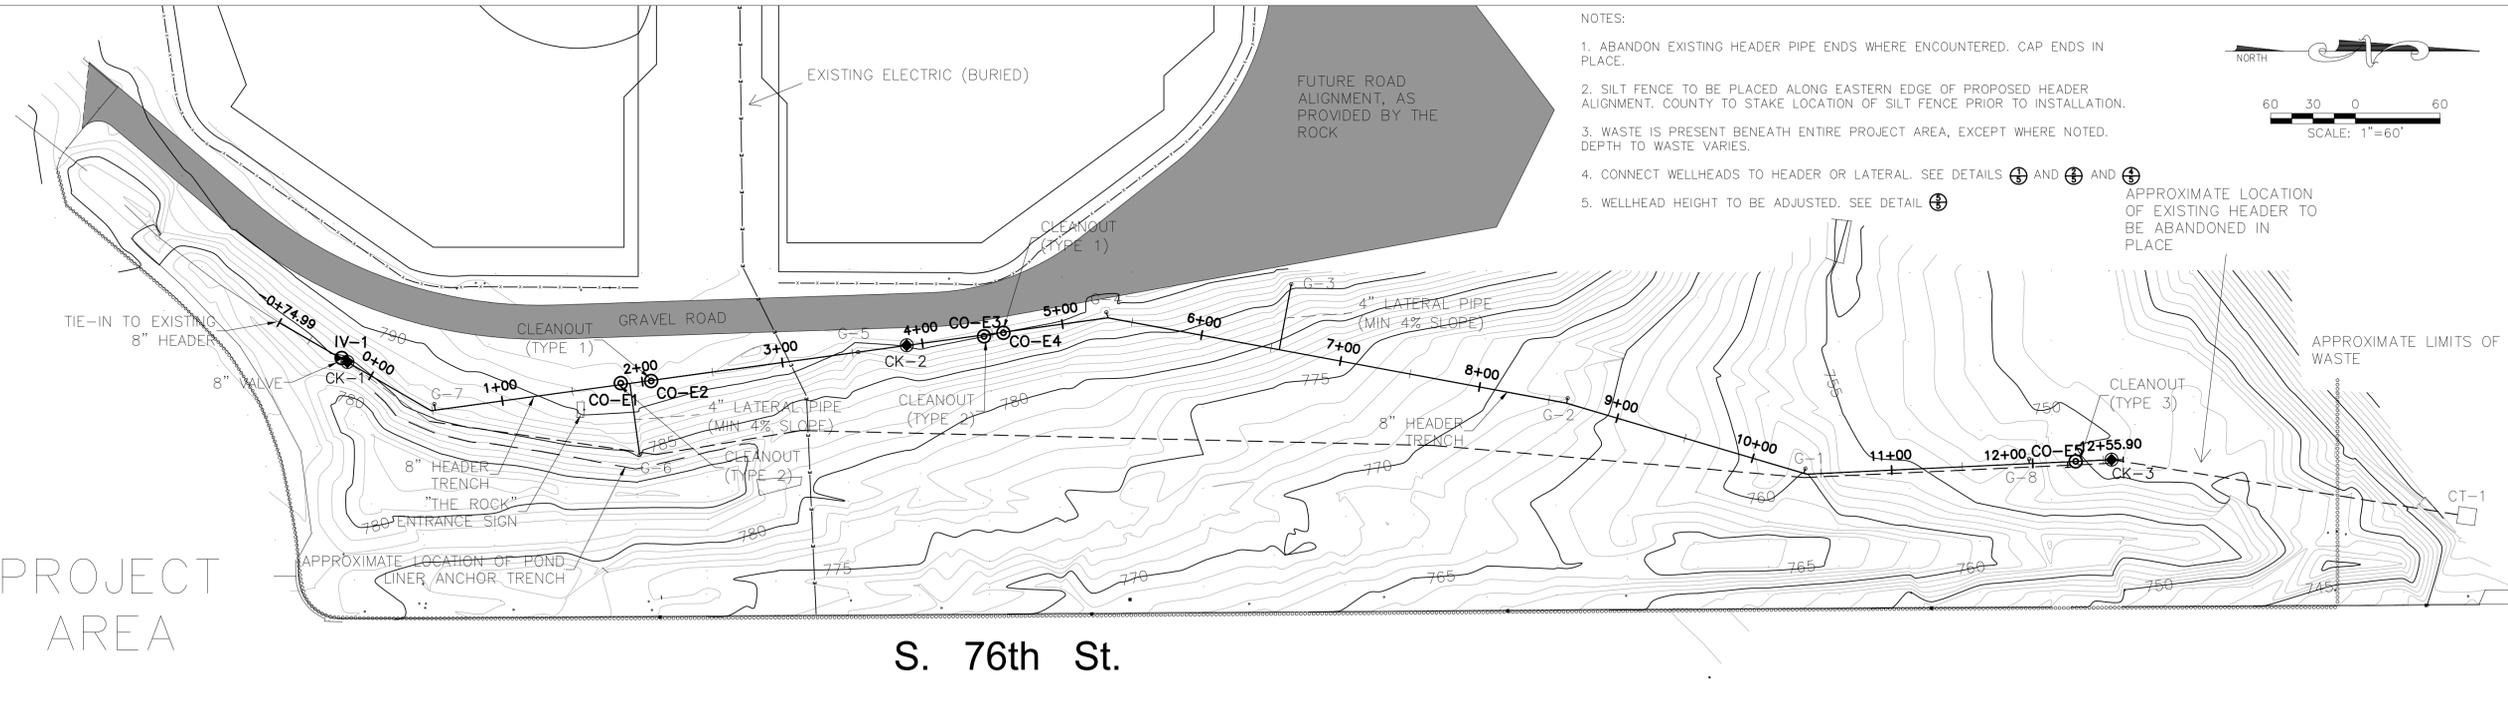


- NOTES:
1. ABANDON EXISTING HEADER PIPE ENDS WHERE ENCOUNTERED. CAP ENDS IN PLACE.
 2. SILT FENCE TO BE PLACED ALONG EASTERN EDGE OF PROPOSED HEADER ALIGNMENT. COUNTY TO STAKE LOCATION OF SILT FENCE PRIOR TO INSTALLATION.
 3. WASTE IS PRESENT BENEATH ENTIRE PROJECT AREA, EXCEPT WHERE NOTED. DEPTH TO WASTE VARIES.
 4. CONNECT WELLHEADS TO HEADER OR LATERAL. SEE DETAILS (C) AND (D) AND (E)
 5. WELLHEAD HEIGHT TO BE ADJUSTED. SEE DETAIL (F)

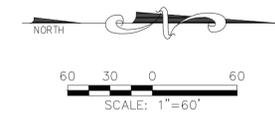

S. 76th St.

LONGITUDINAL PROFILE Proposed Header

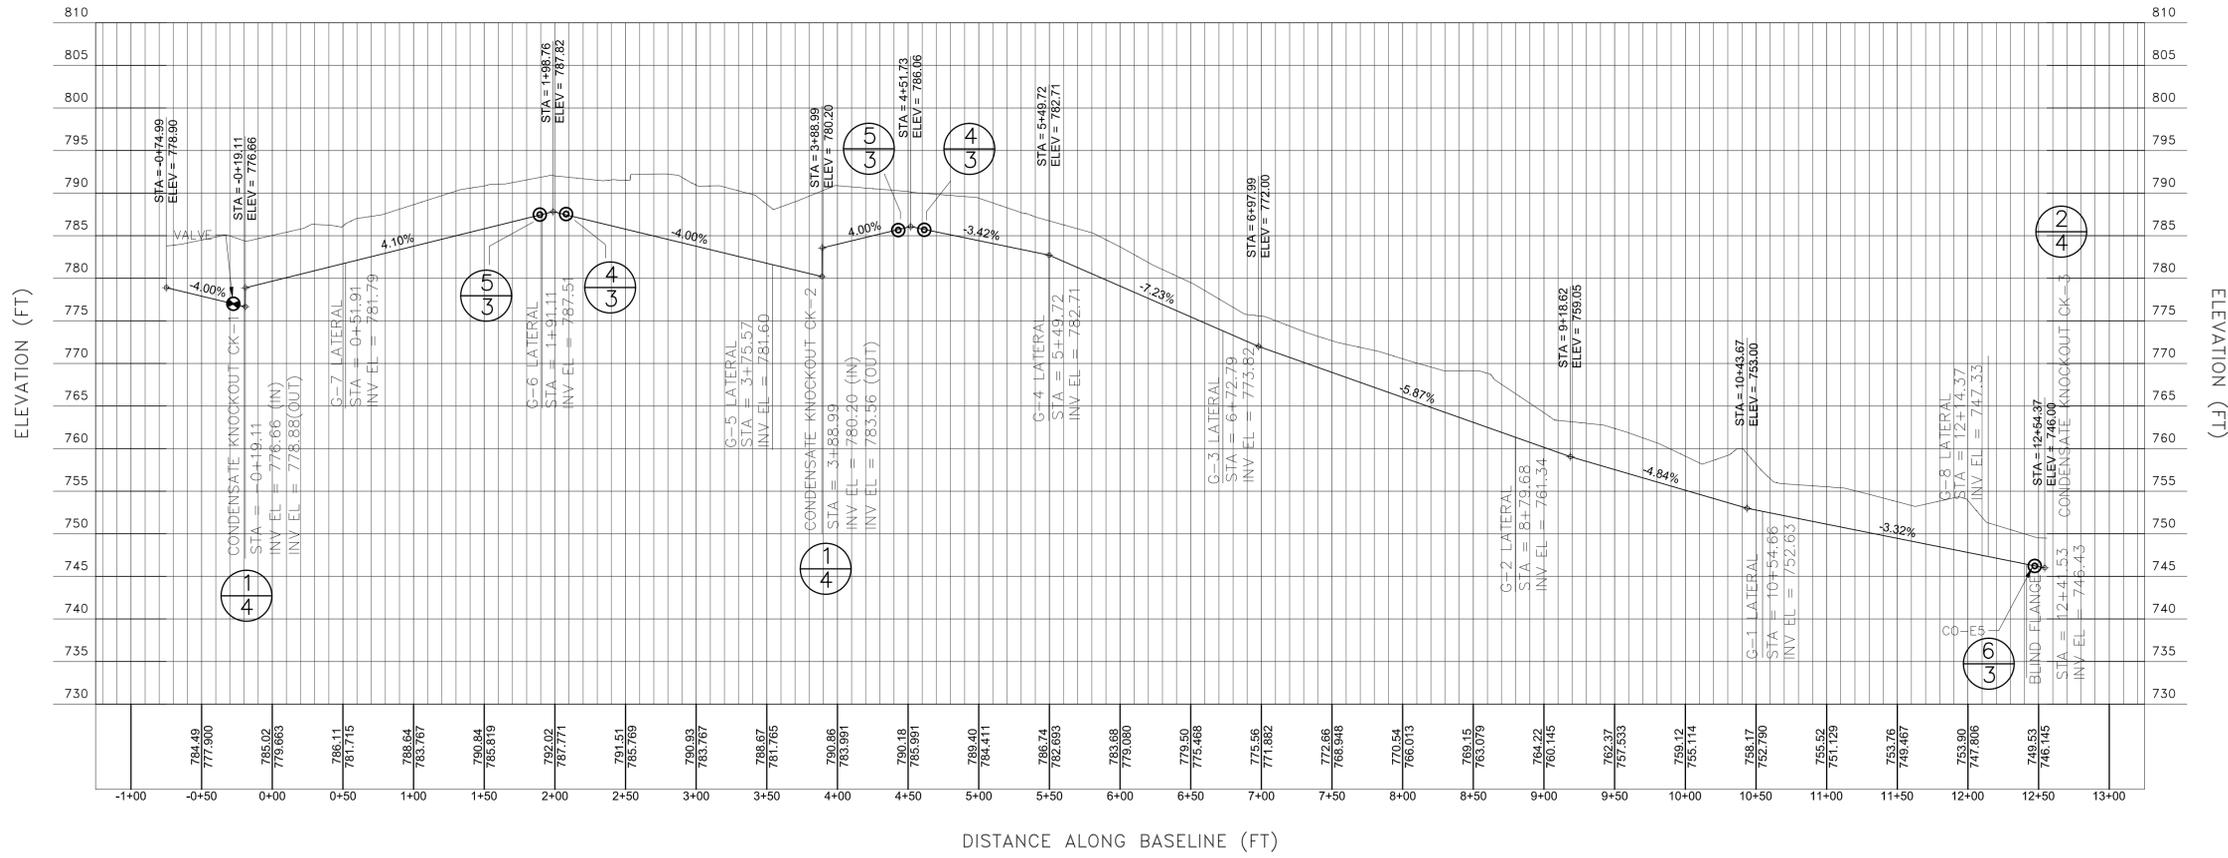

PROFILE SCALE:
 HORIZ: 1"=60'
 VERT: 1"=10'



MILWAUKEE COUNTY DEPARTMENT OF ADMINISTRATIVE SERVICES
 Architecture, Engineering & Environmental Services Section
 633 W. WISCONSIN AVE. SUITE 1000, MILWAUKEE, WI. 53203



DRAWN BY:	FDB
CHECKED BY:	
SCALE:	AS SHOWN
DATE:	OCT 2015

PROJECT TITLE:	EASTERN INFRASTRUCTURE UPDATE
SHEET DESCRIPTION:	HEADER PLAN AND PROFILE (Revised 11/5/15)
SITE NO.	
BUILDING NO.	

ENGINEER	PROJECT NO.	V022-15803
	SHEET NO.	6
		2
	FILE NO.	